



FORM 27 Rev 6/99

State of Colorado Oil and Gas Conservation Commission 1120 Lincoln Street, Suite 801, Denver, Colorado 80203 (303)894-2100 Fax:(303)894-2109



Tracking Number: Name of Operator: Wexpro OGCC Operator No: 95960 Received Date: Well Name & No: Facility Name & No: 100401 / 100402

Page 2 REMEDIATION WORKPLAN (Cont.)

OGCC Employee:

If groundwater has been impacted, describe proposed monitoring plan (# of wells or sample points, sampling schedule, analytical methods, etc.):

No indication that groundwater was impacted.

Describe reclamation plan. Discuss existing and new grade recontouring; method and testing of compaction alleviation; and reseeding program, including location of new seed, seed mix and noxious weed prevention. Attach diagram or drawing. Use additional sheet for description if required.

Stored spoil materials were used to backfill the pit and re-contour the location similar to the surrounding terrain. The entire location will be reclaimed and topsoil will be applied to all areas of re-contouring. The approved BLM seedmix will be used: Shadscale, Thickspike wheatgrass, Fourwing Saltbush, Indian Rice Grass, Gardner Saltbush, Bottlebrush Squirreltail, Western Wheatgrass, Great Basin Wildrye, Slender Wheatgrass, Lewis Blue Flax, and Rocky Mtn. Beeplant during the fall of 2012. Weeds will sprayed annually as part of the Wexpro Weed Prevention Program approved by the BLM.

Attach samples and analytical results taken to verify remediation of impacts. Show locations of samples on an onsite schematic or drawing.

Is further site investigation required? [X] Y [ ] N If yes, describe:

Final disposition of E&P waste (landtreated and disposed onsite, name of licensed disposal facility, recycling, reuse, etc.):

IMPLEMENTATION SCHEDULE

Date Site Investigation Began: 9/2011 Date Site Investigation Completed: 7/6/15 Date Remediation Plan Submitted: 7/6/15 Remediation Start Date: Anticipated Completion Date: Actual Completion Date: 7/6/15

I hereby certify that the statements made in this form are, to the best of my knowledge, true, correct, and complete.

Print Name: Tammy Fredrickson Signed: Tammy Fredrickson Title: Senior Permit Agent Date: August 25, 2015

OGCC Approved: Kim Neidel Title: EPS Date: 9/3/15

SEE attached COA'S

Conditions of Approval for project on 100401 and 100402

- The vertical and horizontal extent of the pit should be determined through the soil investigation.
- Discrete samples (minimum of 3-5) should be taken from pit wall; with at least one from the true pit bottom. Samples should be taken to adequately characterize any impact from pit.
- Samples should be analyzed for table 910-1.
- Guidance for sample locations should be taken from rule 910.b(3)B
- Final Reclamation should comply with 1004 rules.
- Operator should provide notice to Environmental staff Kris Neidel (Kris Neidel State Co. US) or 970-871-1963 72hrs prior to mobilization at begin of work.

Is the historical imagery from Google Earth contained in the Form 27 what was used to determine pit locations? It is difficult to determine from that imagery the location of the pits. Geology Field notes should be included in final report to assure that sample locations were correct.

State 1 - Proposed Sample Locations




Google earth




X - Pit Sample Locations

X - Offsite Sample Locations

State 1 - Torriarthents

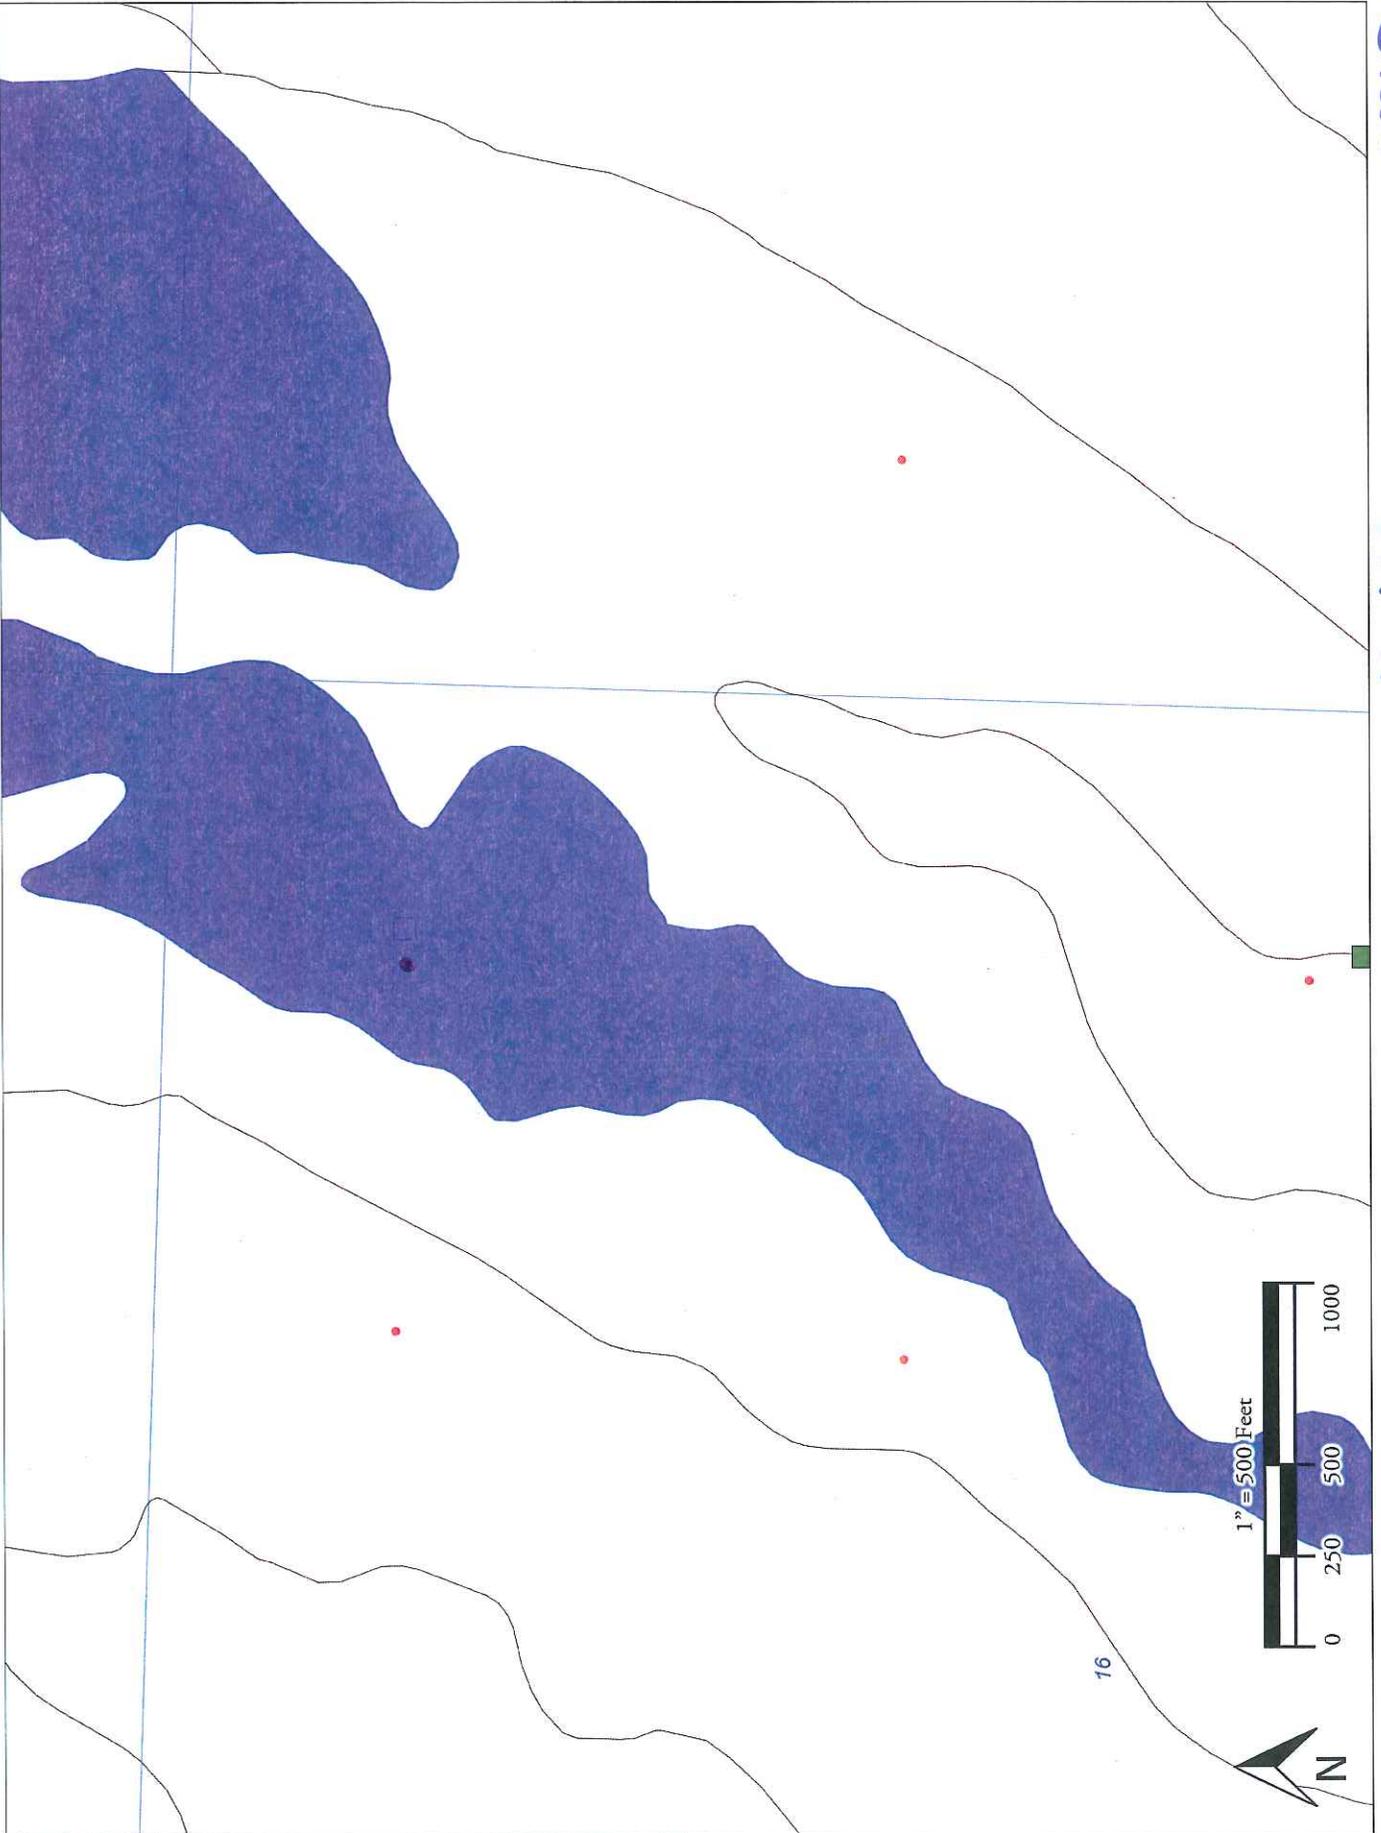

Sheet 1

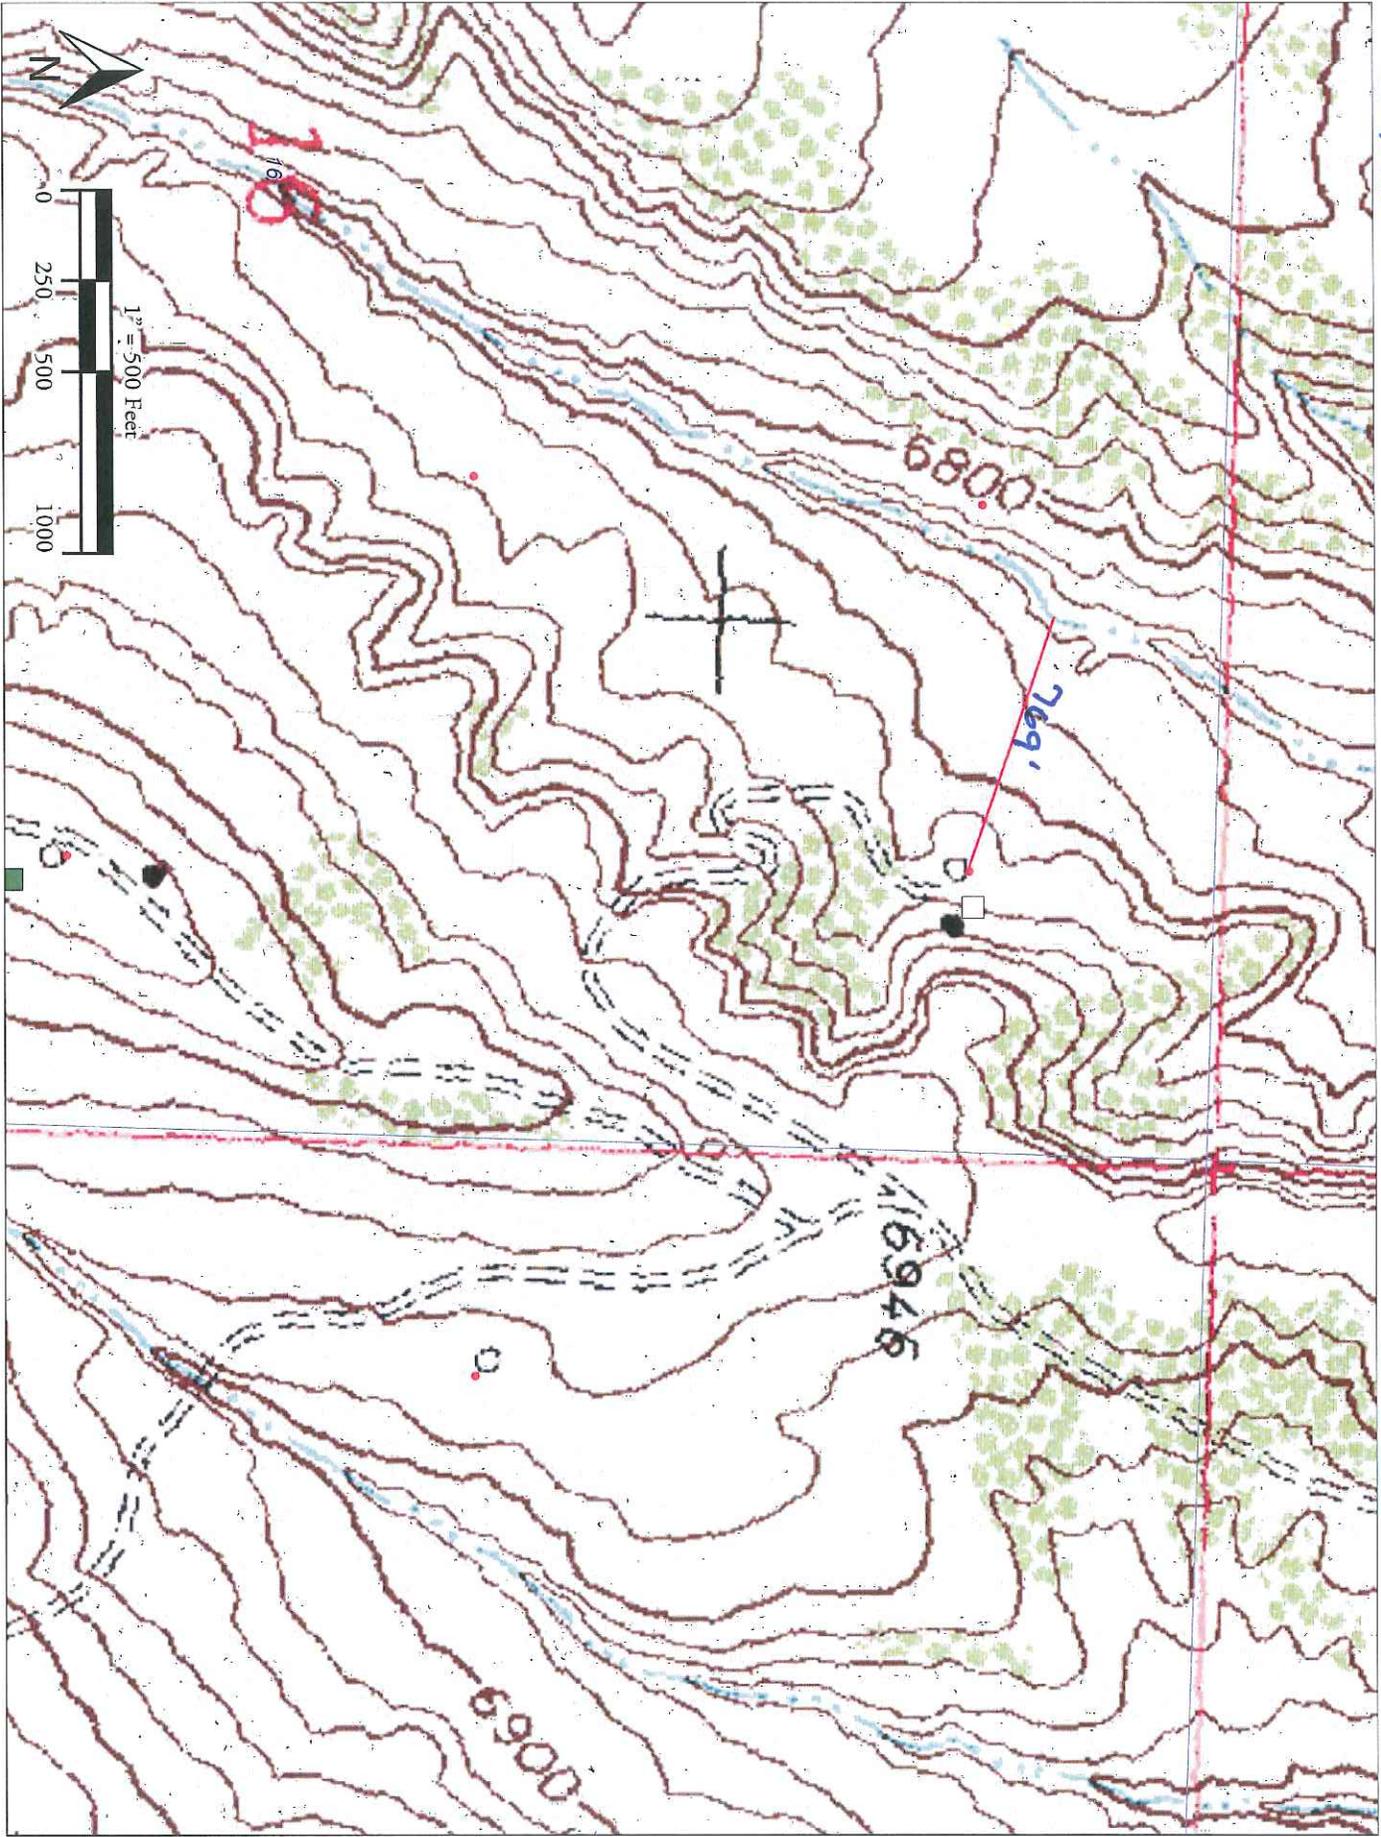

4/2014 - Historical Imagery



Google earth

feet  
meters



Google earth

10/2011 - Historical Imagery



Survey

Image USDA Plant Services Agency

Google earth

Google earth

feet  
meters



8/2006 - Historical Imagery

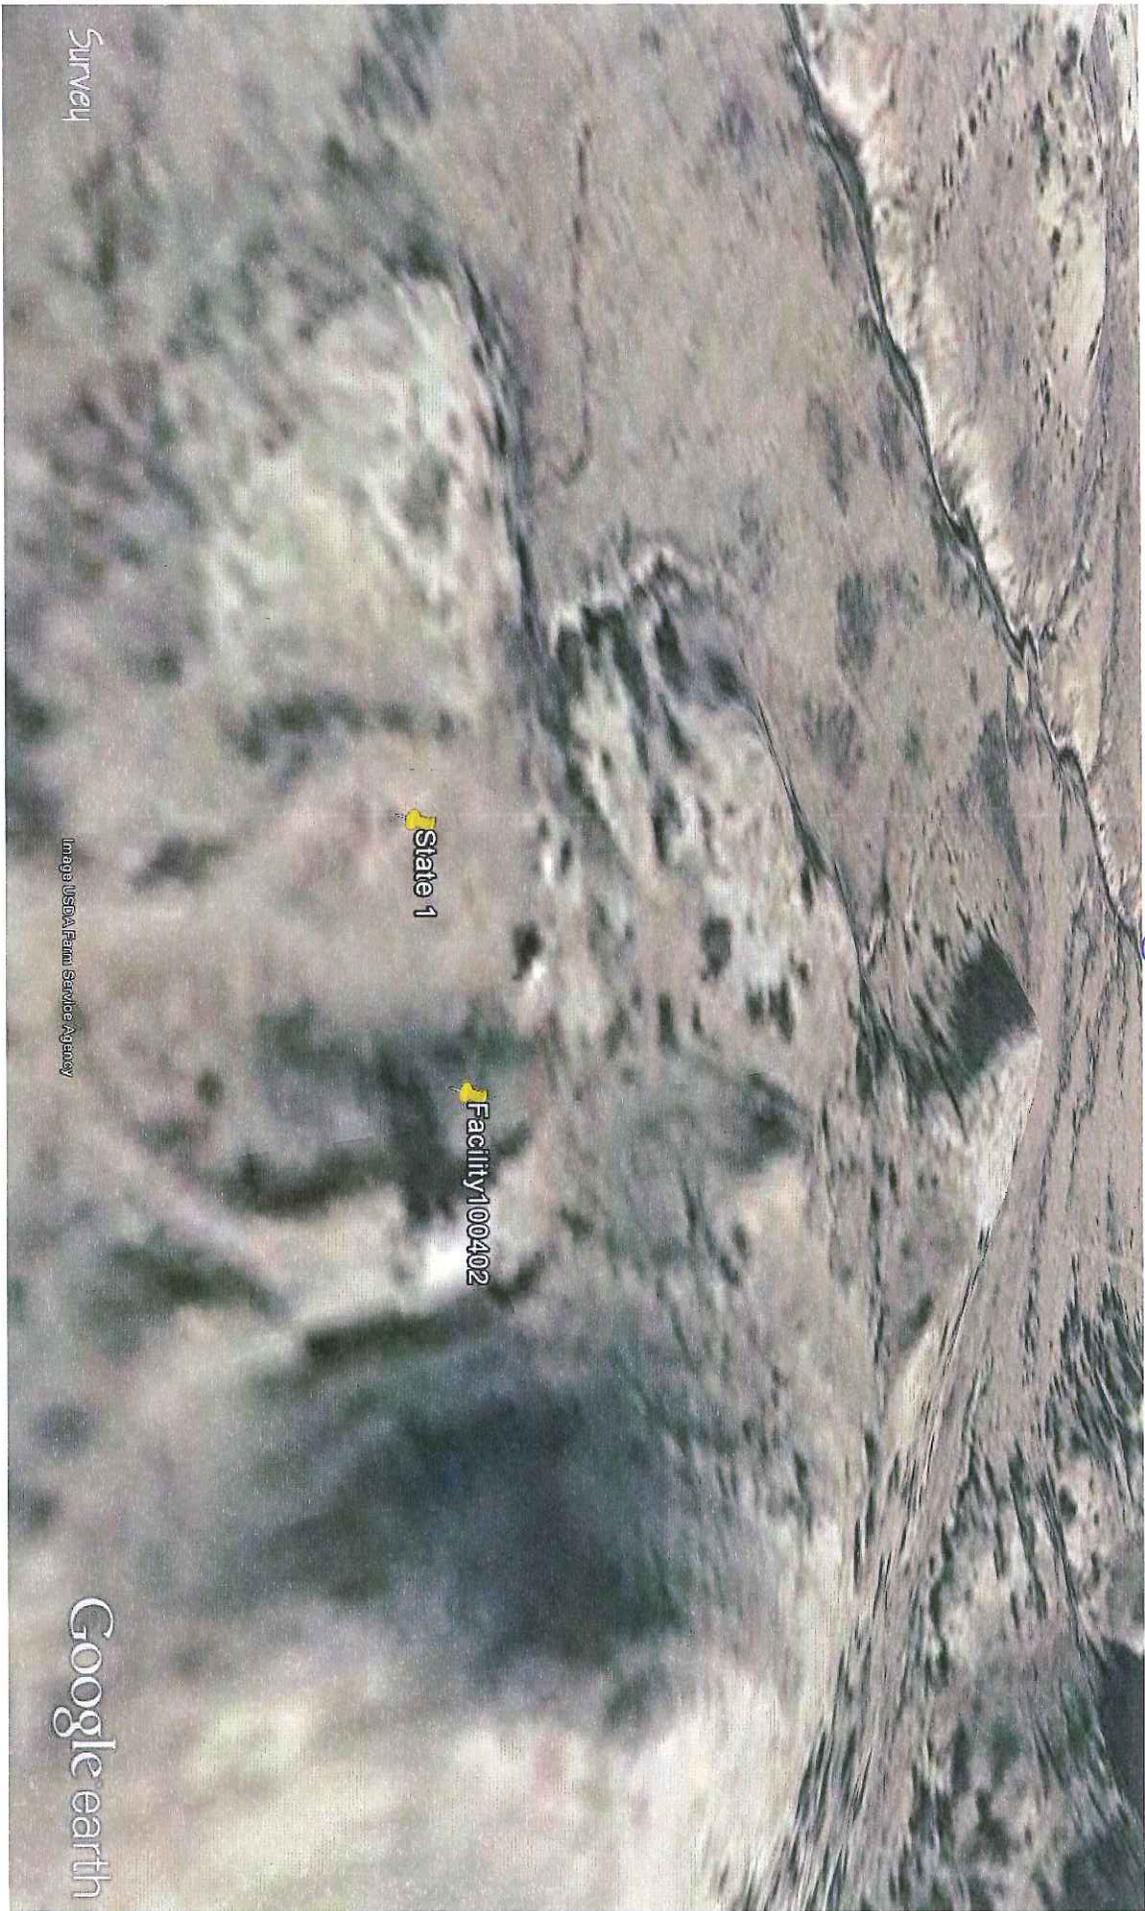


Image USDA Farm Service Agency

Google earth

feet  
meters



Google earth

3/2006 - Historical Imagery




Survey

Image USDA Farm Service Agency

Google earth

Google earth




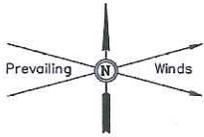

WEXPRO COMPANY  
AS-BUILT SITE PLAN FOR  
STATE OF COLORADO #1  
SECTION 16, T11N, R97W, 6th P.M.  
NE 1/4 NE 1/4

FIGURE #1

SCALE: 1" = 50'  
DATE: 07-12-12  
DRAWN BY: J.M.H.

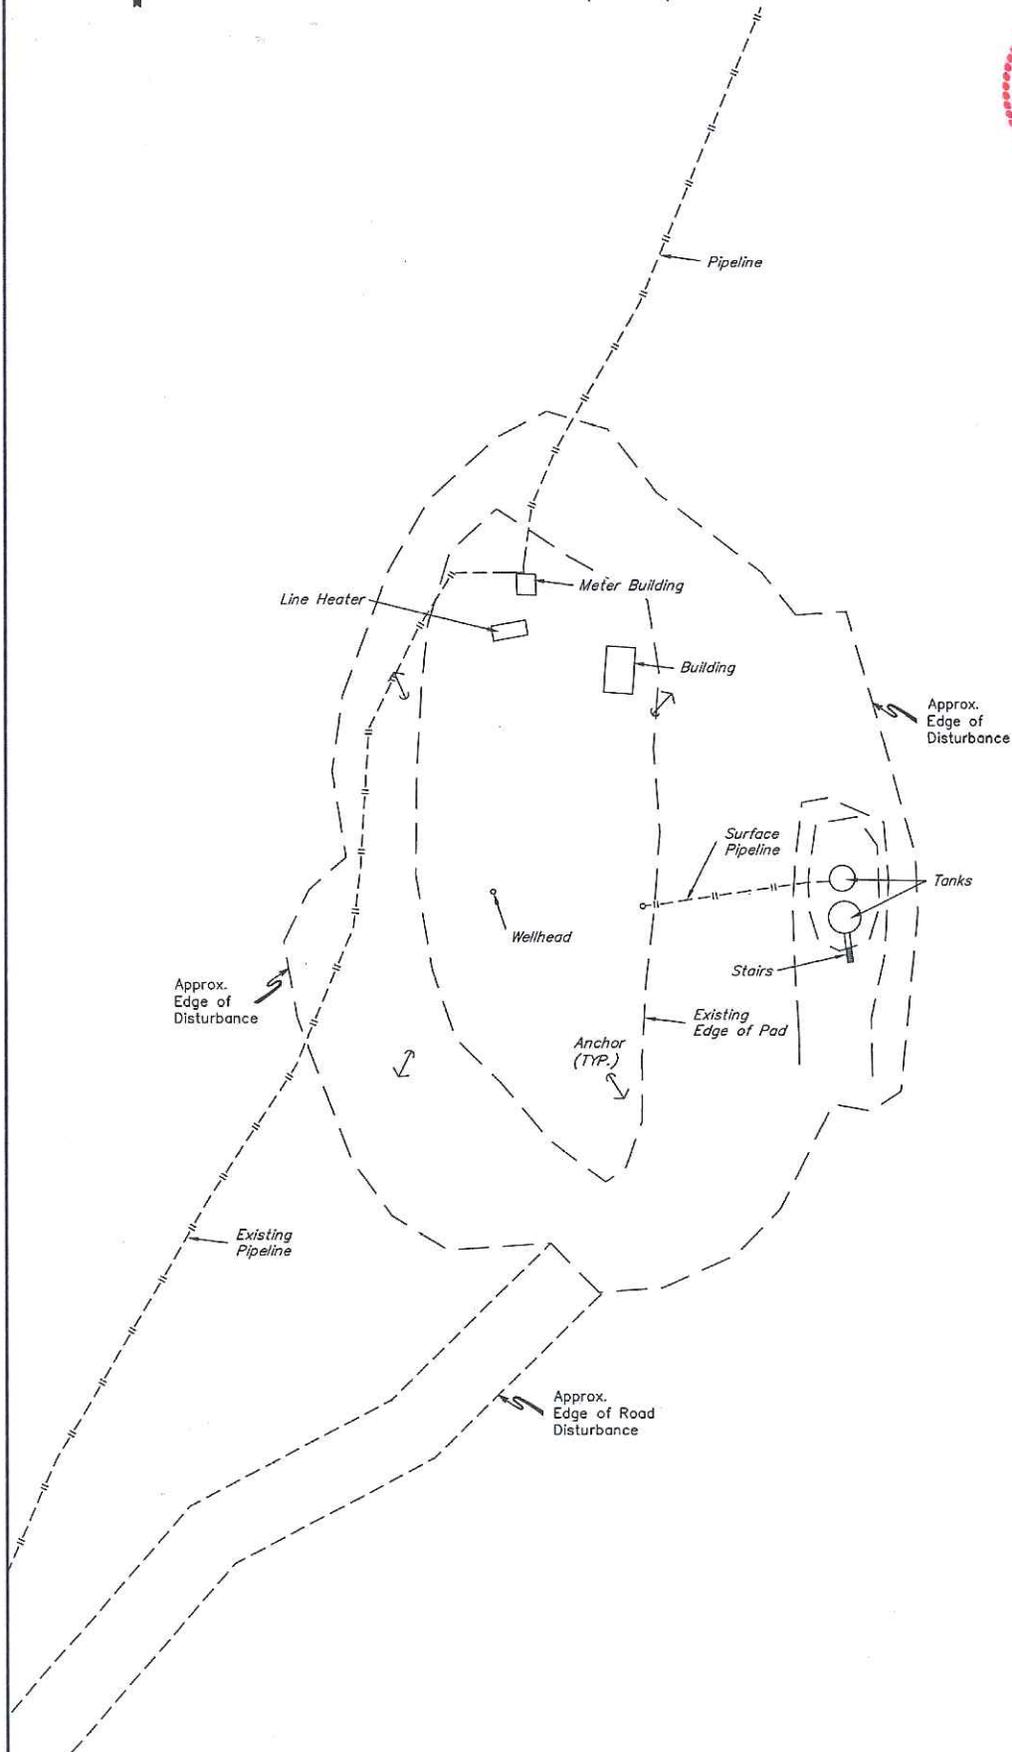

FINISHED GRADE ELEV. AT LOC. STAKE = 6827.4'

UINTAH ENGINEERING & LAND SURVEYING  
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