


EXXON MOBIL CORPORATION

FIGURE #1

LOCATION LAYOUT

WELL PAD (EXPANDED LIBERTY UNIT 396-6A)
Well: EXPANDED LIBERTY UNIT 396-6A1
Section 6, T3S, R96W, 6th P.M.

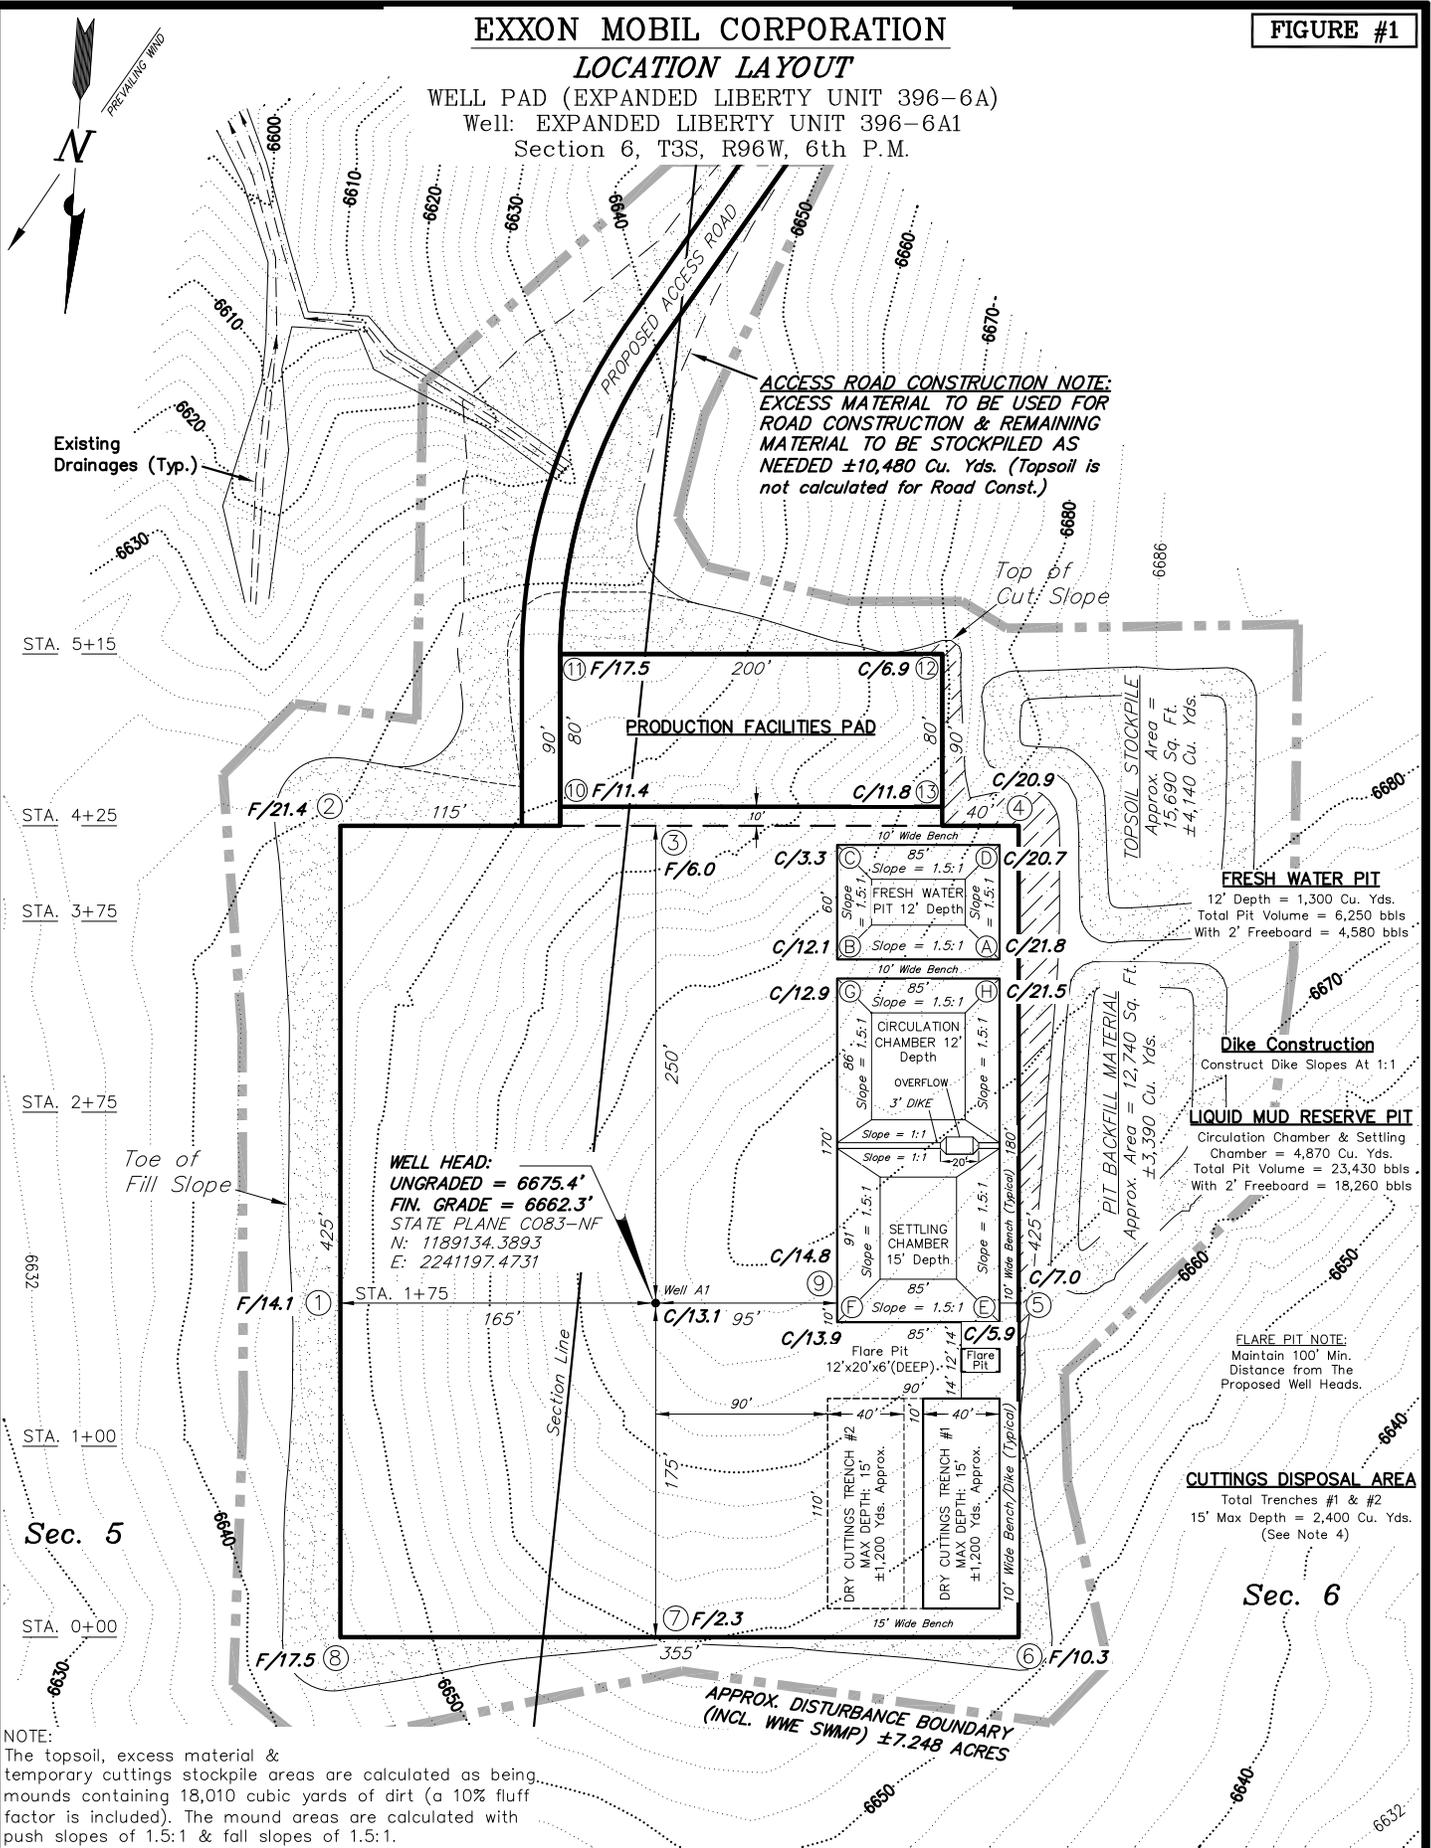

SURVEYED BY: D.P.	DATE SURVEYED: 03-06-09
DRAWN BY: D.COX	DATE DRAWN: 03-07-09
SCALE: 1" = 100'	REVISED: F.T.M. 01-21-10

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SHEET 2

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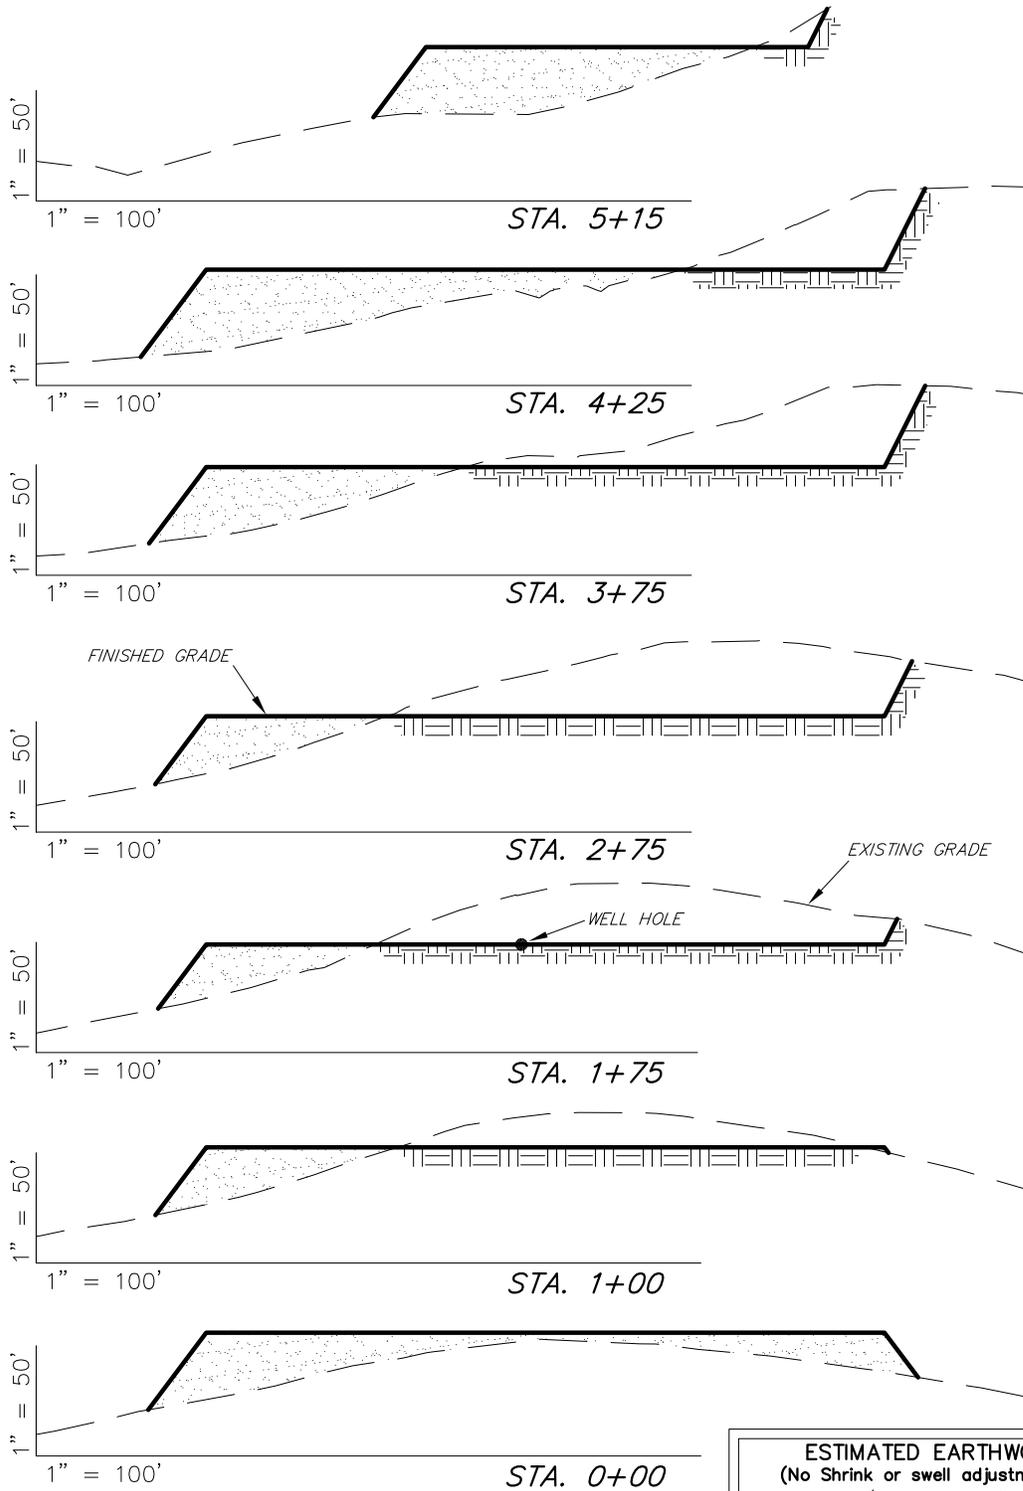
FIGURE #2

CROSS SECTIONS

WELL PAD (EXPANDED LIBERTY UNIT 396-6A)

Well: EXPANDED LIBERTY UNIT 396-6A1

Section 6, T3S, R96W, 6th P.M.



* 1,110 CU. YDS. OF MATERIAL IS REQUIRED TO BE EXCAVATED & STOCKPILED TO COMPLETE THE FINISH GRADING PLAN AS SHOWN ON SHEET 5.

NOTE:
UNLESS OTHERWISE NOTED CUT SLOPES ARE AT 1:1 & FILL SLOPES ARE AT 1.5:1

ESTIMATED EARTHWORK QUANTITIES (No Shrink or swell adjustments have been used) (Expressed in Cubic Yards)				
ITEM	CUT	FILL	6" TOPSOIL	EXCESS
FINISH GRADING	*1,460	*350	Topsoil is not included in Pad Cut	*1,110
PITS	6,170	0		6,170
PAD	36,380	31,050	0	5,330
TOTALS	44,010	31,400	3,760	12,610

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SHEET 3

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FIGURE #4

TYPICAL FINISH GRADING PLAN

WELL PAD (EXPANDED LIBERTY UNIT 396-6A)

Well: EXPANDED LIBERTY UNIT 396-6A1


Section 6, T3S, R96W, 6th P.M.

CONTOUR AND ELEVATION NOTE:

THE REFERENCE ELEVATION OF 100.00 IS EQUAL TO THE ACTUAL FINISHED GRADE ELEVATION ON THE LOCATION LAYOUT (SHEET 2). ALL OTHER ELEVATIONS ARE RELATIVE TO THIS REFERENCE ELEVATION.

* 1,110 CU. YDS. OF MATERIAL IS REQUIRED TO BE EXCAVATED & STOCKPILED TO COMPLETE THE FINISH GRADING PLAN.

Finish Grading Plan
(Note 3)

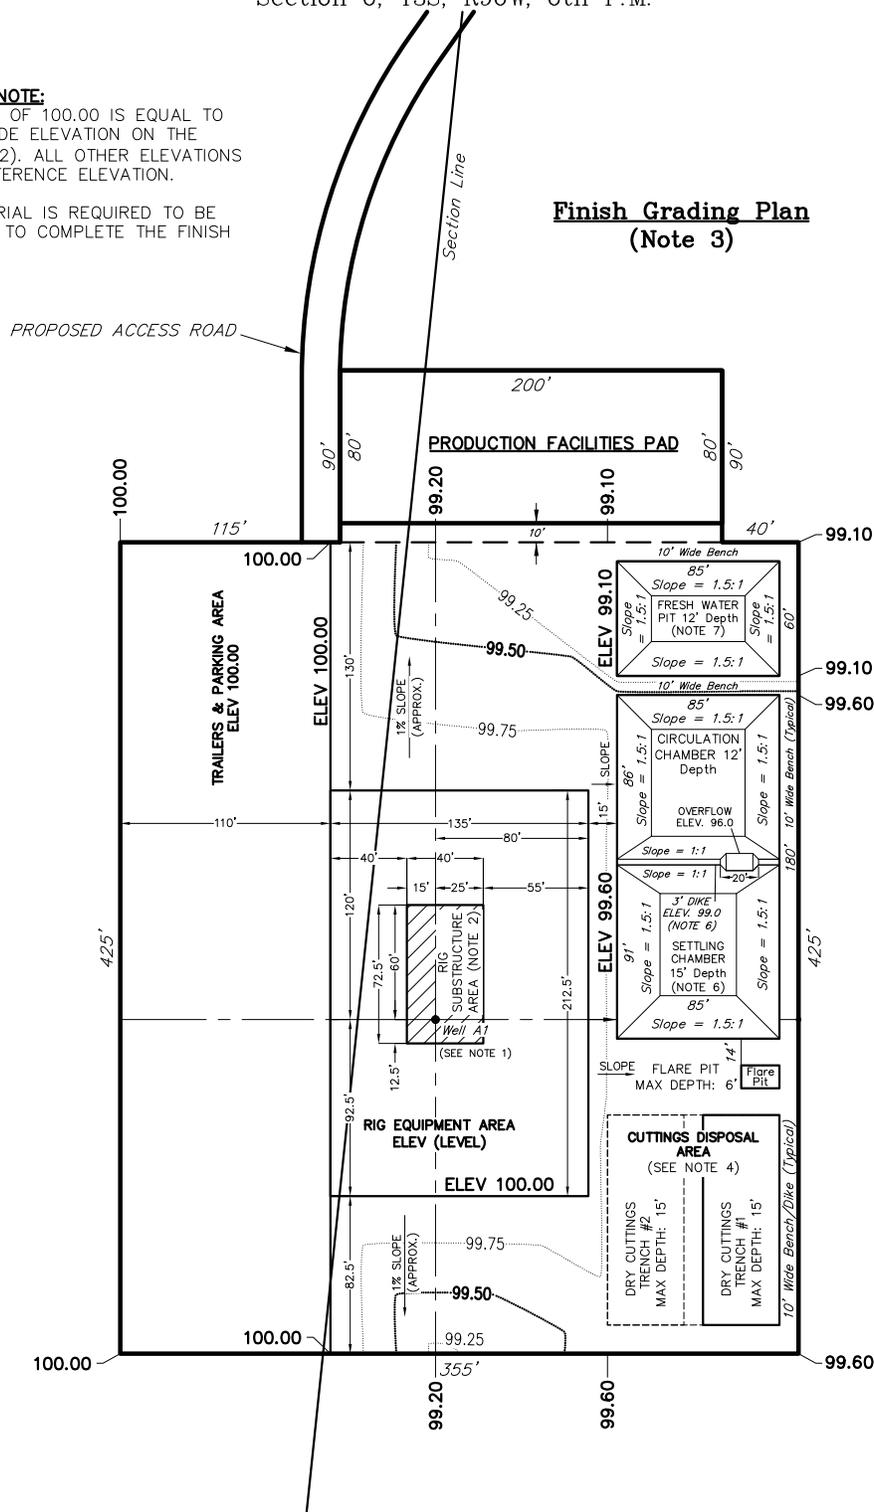

FRESH WATER PIT
12' Depth = 1,300 Cu. Yds.
Total Pit Volume = 6,250 bbls
With 2' Freeboard = 4,580 bbls

Dike Construction
Construct Dike Slopes At 1:1

LIQUID MUD RESERVE PIT
Circulation Chamber & Settling Chamber = 4,870 Cu. Yds.
Total Pit Volume = 23,430 bbls
With 2' Freeboard = 18,260 bbls

FLARE PIT NOTE:
Maintain 100' Min. Distance from The Proposed Well Heads.

CUTTINGS DISPOSAL AREA
Total Trenches #1 & #2
15' Max Depth = 2,400 Cu. Yds.
(See Note 4)

Notes

1. Layout to be used for single well construction.
2. Rig Substructure Area to be level. Compaction and testing per wellpad construction specification.
3. Perimeter ditching not shown. Grading plan to be coordinated with approved Individual Storm Water Management Plan for each site.
4. Cuttings Trench #1 to be constructed with wellpad. Additional trenches will be constructed during drilling operations as required.
5. Indicated spacing may be increased to 75' based upon site topography. Alternate access location may be selected based upon site topography and direction of primary (existing) access.
6. Excavate Reserve Pit to initial 12' depth. Construct diversion dike with 3.0' additional excavation from settling chamber.
7. Fresh Water Pit to be constructed only if required by Drilling.

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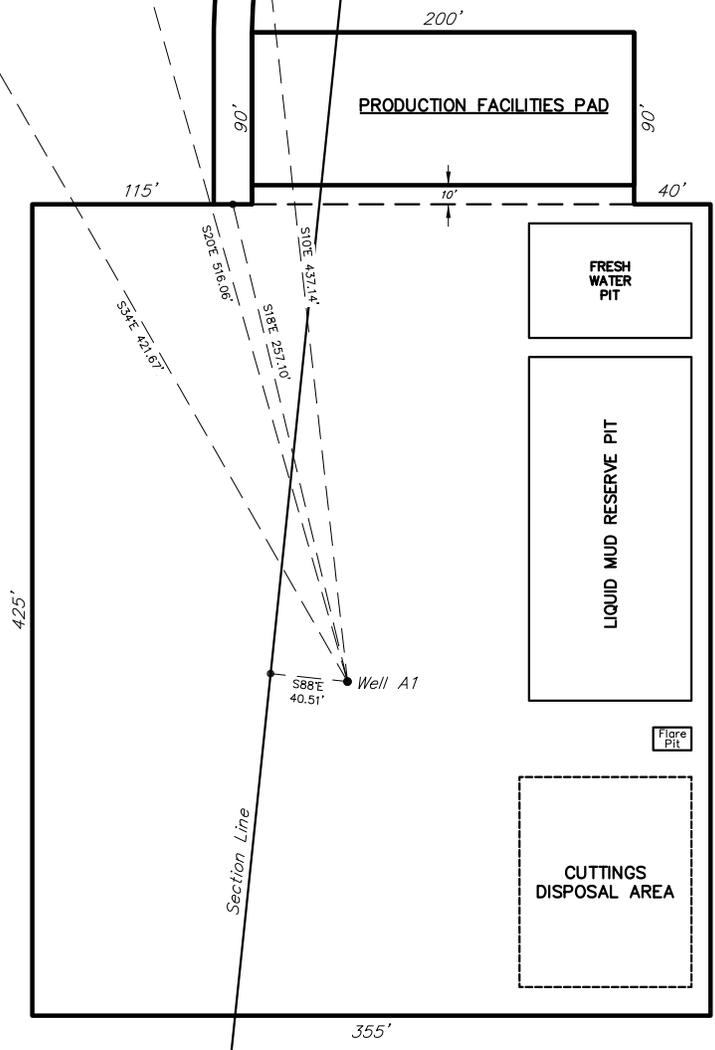
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SHEET
5


EXXON MOBIL CORPORATION
ADDENDUM TO LEGAL PLATS FOR
WELL PAD (EXPANDED LIBERTY UNIT 396-6A)
 Well: EXPANDED LIBERTY UNIT 396-6A1
 Section 6, T3S, R96W, 6th P.M.

Existing Drainages (Typ.)

PROPOSED ACCESS ROAD



FLARE PIT NOTE:
 Maintain 100' Min.
 Distance from The
 Proposed Well Heads.

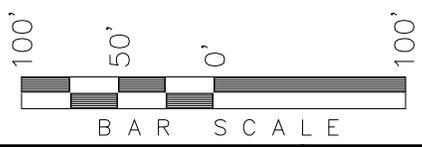

SURFACE USE NOTE:
 Surface use of the well site is grazing.
 Vegetation consists mainly of Pinion Trees,
 Juniper Trees, Sagebrush & Native Grasses.

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SHEET 1b